
SPOIL SITE GARRETT COLLEGE

687 MOSSER ROAD
McHENRY, MARYLAND 21541
TELEPHONE: (301) 387-3095

REVISIONS

NUMBER	DESCRIPTION	DATE
-	ISSUED FOR BIDDING	12/7/2022
-	-	-

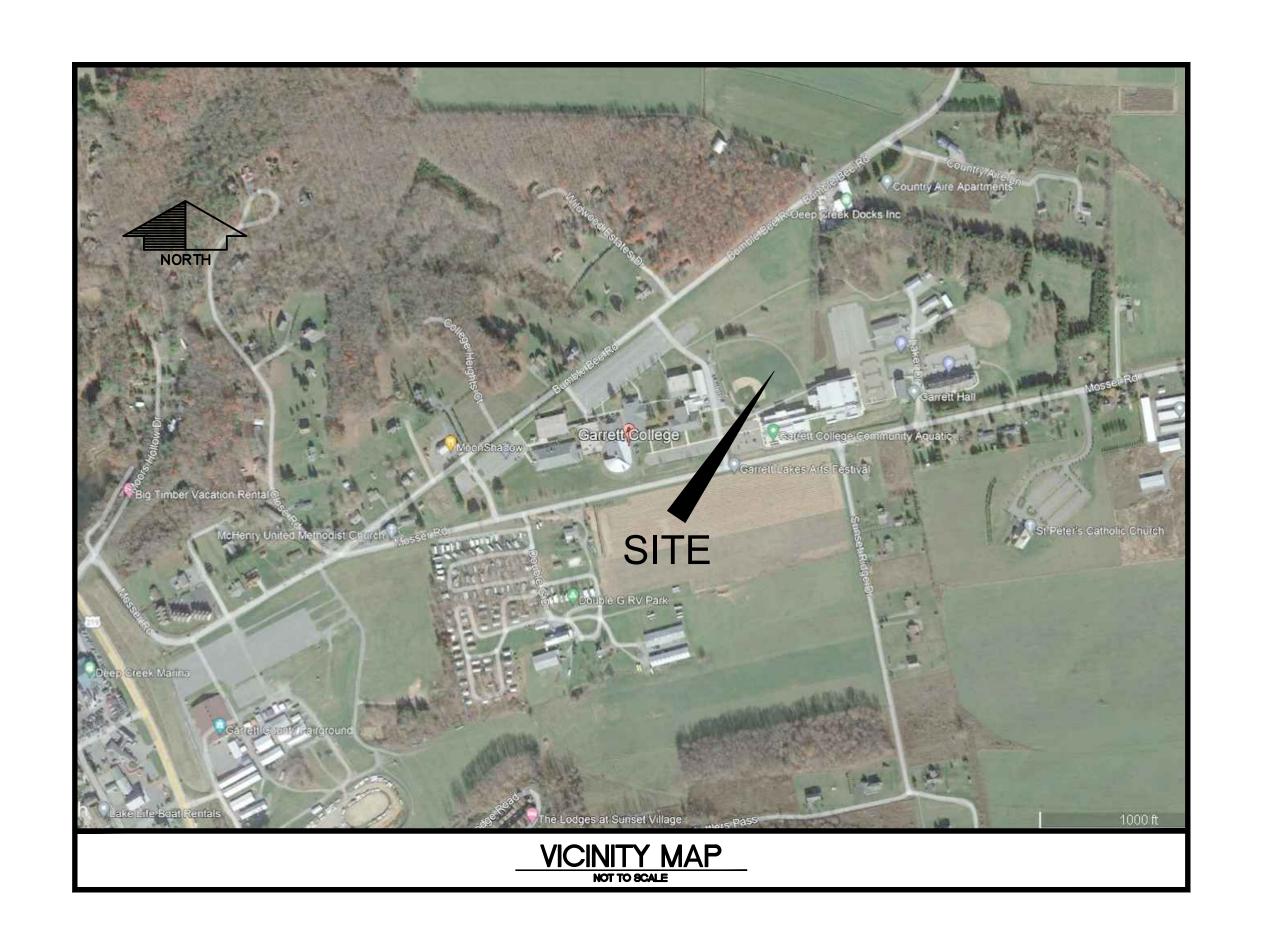


OWNER'S DEVELOPER'S CERTIFICATION						
I / WE HEREBY CERTIFY THAT ALL CLEARING, GRADING, CONSTRUCTION, AND/OR DEVELOPMENT WILL BE DONE PURSUANT TO THIS PLAN AND THAT ANY RESPONSIBLE PERSONNEL INVOLVED IN THE CONSTRUCTION PROJECT WILL HAVE A CERTIFICATE OF ATTENDANCE AT A MARYLAND DEPARTMENT OF THE ENVIRONMENT APPROVED TRAINING PROGRAM FOR THE CONTROL OF EROSION AND SEDIMENT BEFORE BEGINNING THE PROJECT. I/WE HEREBY AUTHORIZE THE RIGHT OF ENTRY FOR PERIODIC ON—SITE EVALUATION BY APPROPRIATE INSPECTION AND ENFORCEMENT AUTHORITY OR THE STATE OF MARYLAND, DEPARTMENT OF THE ENVIRONMENT. I/WE HEREBY CERTIFY THAT STORMWATER MANAGEMENT FACILITIES WILL BE MAINTAINED IN ACCORDANCE WITH APPROVED PLANS.						
DATE:		OWNER/DEVELOPER SIGNATURE:				
RESPONSIBLE PERSONI	NEL CERTIFICATION NO.	PRINTED NAME & TITLE:				
DESIGN CERTIFICATION						
	<u>DESIGN CER</u>	TIFICATION_				
MARYLAND STANDAR	THAT THIS PLAN HAS BEEN DES RDS AND SPECIFICATIONS FOR S D STORMWATER DESIGN MANUA	IFICATION GIGNED IN ACCORDANCE WITH THE 2011 GOIL EROSION AND SEDIMENT CONTROL, , VOLUMES I & II AND ACCEPTED				
MARYLAND STANDAR THE 2010 MARYLANI	THAT THIS PLAN HAS BEEN DES RDS AND SPECIFICATIONS FOR S D STORMWATER DESIGN MANUA	IGNED IN ACCORDANCE WITH THE 2011 COIL EROSION AND SEDIMENT CONTROL,				
MARYLAND STANDAR THE 2010 MARYLANI	THAT THIS PLAN HAS BEEN DES RDS AND SPECIFICATIONS FOR S D STORMWATER DESIGN MANUA INEERING PRACTICE.	GOIL EROSION AND SEDIMENT CONTROL,				
MARYLAND STANDAR THE 2010 MARYLANI STANDARDS OF ENG	THAT THIS PLAN HAS BEEN DESIGNS AND SPECIFICATIONS FOR SECOND STORMWATER DESIGN MANUAL INEERING PRACTICE. 301-777-2510 PHONE NO.:	GORED IN ACCORDANCE WITH THE 2011 SOIL EROSION AND SEDIMENT CONTROL, , VOLUMES I & II AND ACCEPTED				
MARYLAND STANDAR THE 2010 MARYLANI STANDARDS OF ENG DATE:	THAT THIS PLAN HAS BEEN DESIGNS AND SPECIFICATIONS FOR SD STORMWATER DESIGN MANUAL INEERING PRACTICE. 301-777-2510 PHONE NO.: 0. 200457	IGNED IN ACCORDANCE WITH THE 2011 SOIL EROSION AND SEDIMENT CONTROL, , VOLUMES I & II AND ACCEPTED DESIGNER'S SIGNATURE:				

GENERAL NOTES:

- THE GRADING LIMITS SHOWN ON THE PLANS ARE NOT TO BE EXCEEDED. ANY CHANGES IN THE GRADING, EROSION AND SEDIMENT CONTROL PLAN, STORM WATER MANAGEMENT FACILITY OR OTHER SEGMENT OF THE WORK MUST BE REVIEWED AND APPROVED BY THE GARRETT COUNTY PERMITS AND SCS.
- CONTRACTOR IS TO PROVIDE ACCESS TO THE ENTIRE PROJECT AREA FOR EMERGENCY SERVICES DURING THE ENTIRE CONSTRUCTION PROCESS INCLUDING FIRE, AMBULANCE AND POLICE.
- 3. EXISTING UTILITIES:
 THE LOCATIONS OF EXISTING UTILITIES SHOWN ON THE PLANS ARE FOR INFORMATION AND GUIDANCE ONLY. NO GUARANTEE IS MADE AS TO THE ACCURACY OF SAID LOCATION SPECS, INC. ASSUMES NO LIABILITY FOR THE LOCATION AND DEPTH OF ANY ABOVE AN
- 4. THE SPECIFICATIONS FOR THIS PROJECT SHALL BE THOSE OF THE MARYLAND STATE HIGHWAY ADMINISTRATION TITLED "STANDARD SPECIFICATIONS FOR CONSTRUCTION AND MATERIALS", LATEST ADDITION. IN CASE OF A DISCREPANCY BETWEEN THE SPECIAL PROVISIONS AND OTHER PROVISIONS INCLUDED IN THIS CONTRACT THE ENGINEER SHALL BE THE SOLE AUTHORITY AS TO THE PROPER PROCEDURE TO FOLLOW.
- 5. SEDIMENT AND EROSION CONTROL DETAILS INDICATED ON THE PLAN AND APPLICA
- 6. THE DESIGN FOR THIS PROJECT HAS INCORPORATED FACILITIES FOR THE ELDERLY AN
- 7. WHERE REMOVAL OF AN ITEM IS CALLED FOR IN THE CONTRACT DOCUMENTS, IT SHALL BE INTERPRETED AS TO MEAN "REMOVE AND PROPERLY DISPOSE OF", UNLESS OTHERWISE
- 8. THE PROPERTY LINES SHOWN ON THIS DRAWINGS ARE APPROXIMATE AND HAVE BEEN INTERPOLATED FROM DEEDS, PLATS AND BEST AVAILABLE INFORMATION. SPECS, INC. ASSUMES NO LIABILITY FOR THE LOCATION AND/OR EXISTENCE OF ANY PROPERTIES, FASEMENTS AND/OR RIGHT OF WAYS.
- 9. CONTRACTOR SHALL COORDINATE ALL UTILITY CONNECTIONS WITH APPROPRIATE UTILITIES.

Signature		Sign	ature
Title		Date	;
Pond 378 Approval:	Yes	lo 🗌 NA	
APPROVED FOR			<u>ENT</u>
Garrett Coun	ity Storm water	Management	
Engineer		Date)

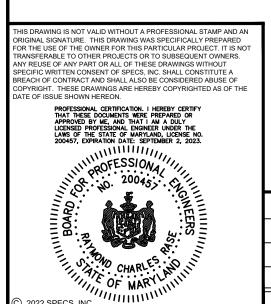

DESIGNED:
R.C.R.

DESCRIPTION

DESCRIPTION

DATE BY

R.C.R.

CHECKED:
R.C.R.


R.C.R.



PREPARED FOR:
GARRETT COLLEGE
687 MOSSER ROAD
McHENRY, MARYLAND 21541
(301) 387-3095

SPOIL SITE GARRETT COLLEGE TITLE SHEET

JOB No.	SHEET No.
5593	C0.0
DECEMBER 2022	DRAWING No. 1 of 4

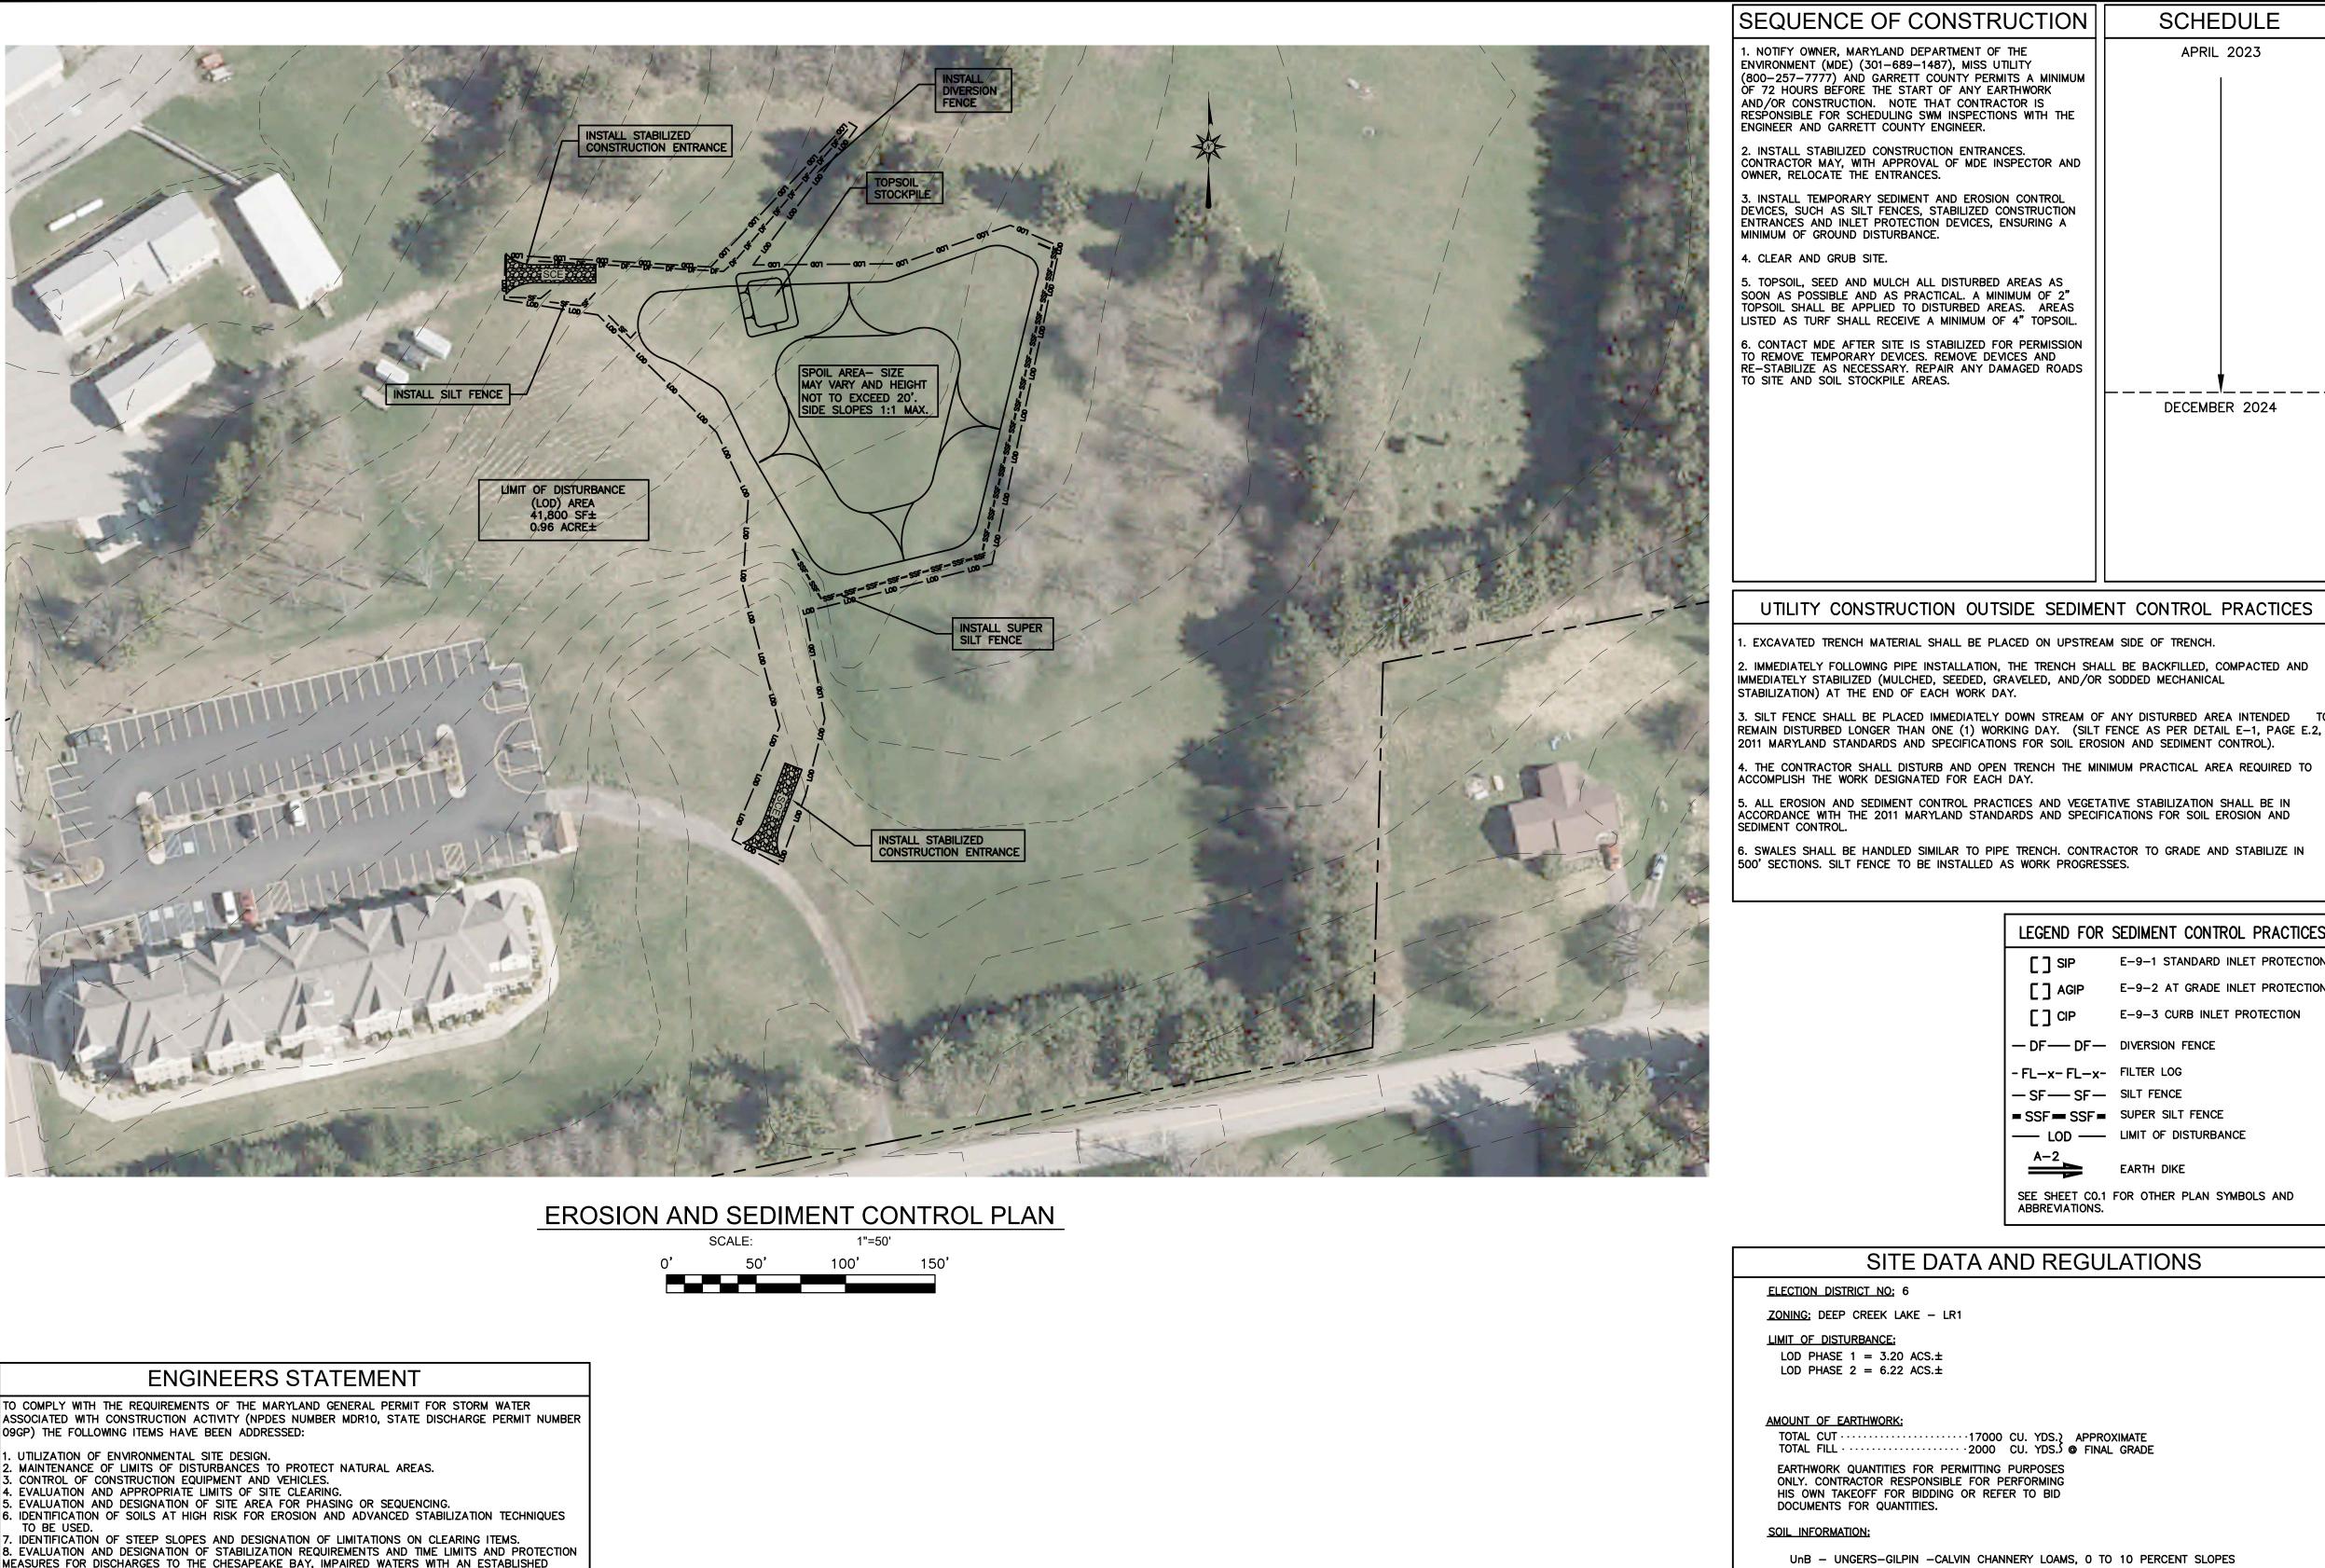

SEQUENCE OF CONSTRUCTION

NOTIFY OWNER, MARYLAND DEPARTMENT OF THE ENVIRONMENT (MDE) (301-689-1487), MISS UTILITY (800-257-7777) AND GARRETT COUNTY PERMITS A MINIMUM OF 72 HOURS BÉFORE THE START OF ANY EARTHWORK AND/OR CONSTRUCTION. NOTE THAT CONTRACTOR IS RESPONSIBLE FOR SCHEDULING SWM INSPECTIONS WITH THE ENGINEER AND GARRETT COUNTY ENGINEER.

2. INSTALL STABILIZED CONSTRUCTION ENTRANCES. CONTRACTOR MAY, WITH APPROVAL OF MDE INSPECTOR AND OWNER, RELOCATE THE ENTRANCES.

. INSTALL TEMPORARY SEDIMENT AND EROSION CONTROL DEVICES, SUCH AS SILT FENCES, STABILIZED CONSTRUCTION ENTRANCES AND INLET PROTECTION DEVICES, ENSURING A MINIMUM OF GROUND DISTURBANCE.

. CLEAR AND GRUB SITE. . TOPSOIL, SEED AND MULCH ALL DISTURBED AREAS AS

LISTED AS TURF SHALL RECEIVE A MINIMUM OF 4" TOPSOIL S. CONTACT MDE AFTER SITE IS STABILIZED FOR PERMISSION TO REMOVE TEMPORARY DEVICES. REMOVE DEVICES AND RE-STABILIZE AS NECESSARY. REPAIR ANY DAMAGED ROADS **SCHEDULE**

APRIL 2023

DECEMBER 2024

LEGEND FOR SEDIMENT CONTROL PRACTICES

- DF - DF - DIVERSION FENCE

SSF SSF SUPER SILT FENCE

— LOD — LIMIT OF DISTURBANCE

EARTH DIKE

SEE SHEET CO.1 FOR OTHER PLAN SYMBOLS AND

·FL-x-FL-x- FILTER LOG

-SF-SF-SILT FENCE

ABBREVIATIONS.

····17000 CU. YDS. APPROXIMATE ····2000 CU. YDS. © FINAL GRADE

NO WETLANDS FOUND IN PROJECT AREA

THE SUBJECT PROPERTY APPEARS TO BE LOCATED IN ZONE X,

OCTOBER 2, 2013. IT WAS NOT THE INTENT OF THIS SURVEY

AS SHOWN ON MAP NO. 24023C0155D, EFFECTIVE DATE

TO STUDY AND/OR MAKE A DETERMINATION AS TO THE ACCURACY OF THE FLOOD ZONE CLASSIFICATION.

*NPDES PERMIT IS REQUIRED.

WETLAND INFORMATION.

FLOODPLAIN INFORMATION.

SITE DATA AND REGULATIONS

E-9-1 STANDARD INLET PROTECTION

E-9-2 AT GRADE INLET PROTECTION

E-9-3 CURB INLET PROTECTION

VICINITY MAP

SCALE: NOT TO SCALE

National Flood Hazard Layer FIRMette R AREAS Area of Undetermined Flo

FLOOD INSURANCE RATE MAP

REQUIRED STANDARD EROSION AND SEDIMENT CONTROL NOTES

. THE CONTRACTOR SHALL PROTECT ALL POINTS OF CONSTRUCTION INGRESS AND EGRESS TO PREVENT THE DEPOSITION OF MATERIALS ONTO PUBLIC ROADS. ALL MATERIALS DEPOSITED ONTO PUBLIC ROADS SHALL BE REMOVED IMMEDIATELY.

2. THE CONTRACTOR SHALL INSPECT DAILY AND MAINTAIN CONTINUOUSLY IN AN EFFECTIVE OPERATING CONDITION ALL EROSION AND SEDIMENT CONTROL MEASURES UNTIL SUCH TIME AS PERMANENT STABILIZATION OF EXPOSED SOIL OCCURS.

3. WHEN PROPERTY IS BROUGHT TO FINISHED GRADE DURING THE MONTHS OF NOVEMBER THROUGH FEBRUARY, AND PERMANENT STABILIZATION IS FOUND TO BE IMPRACTICAL, TEMPORARY SEED AND ANCHORED STRAW MULCH SHALL BE APPLIED TO DISTURBED AREAS. THE FINAL PERMANENT STABILIZATION OF SUCH PROPERTY SHALL BE APPLIED BY APRIL 15 OR EARLIER IF GROUND AND WEATHER CONDITIONS ALLOW.

4. THE SITE'S APPROVED EROSION AND SEDIMENT CONTROL PLANS SHALL BE AVAILABLE

5. THE APPLICANT IS RESPONSIBLE FOR OBTAINING ANY OTHER FEDERAL, STATE, OR LOCAL AUTHORIZATIONS WHICH MAY BE REQUIRED.

6. FOLLOWING INITIAL SOIL DISTURBANCE OR RE-DISTURBANCE, PERMANENT OR TEMPORARY STABILIZATION MUST BE COMPLETED WITHIN

A) THREE (3) CALENDAR DAYS AS TO SURFACE OF ALL PERIMETER DIKES, SWALES, DITCHES, PERIMETER SLOPES, AND ALL SLOPES GREATER THAT 3 HORIZONTAL TO 1

VERTICAL (3:1): AND B) SEVEN (7) DAYS AS TO ALL OTHER DISTURBED OR GRADED AREAS ON THE PROJECT SITE NOT UNDER ACTIVE GRADING.

7. THE APPROVAL OF THIS PLAN MAKES NO REPRESENTATION AS TO THE EXISTENCE OR NONEXISTENCE OF ANY UTILITIES AT THIS SITE. IT IS THE RESPONSIBILITY OF THE LANDOWNERS OR OPERATORS AND CONTRACTORS TO ASSURE THAT NO HAZARD EXISTS OR DAMAGE WILL OCCUR TO UTILITIES. IT IS SUGGESTED THAT MISS UTILITY BE CONTACTED AT: 1-800-257-7777.

GENERAL NOTES

. CONTRACTOR IS RESPONSIBLE FOR PERMITTING ALL BORROW SPOIL, WASTE & DUMP AREAS.

. 1 FOOT CONTOUR INTERVAL, 5 FOOT INDEX CONTOUR INTERVALS.

ALL AREAS WITH SLOPES 2:1 OR STEEPER SHALL BE STABILIZED WITH TYPE A SOIL STABILIZATION FABRIC AND LOW MAINTENANCE SEED MIX.

. CONTRACTOR SHALL SCHEDULE PRECONSTRUCTION MEETING WITH THE MARYLAND DEPARTMENT OF ENVIRONMENT, SOIL CONSERVATION DISTRICT, ENGINEER, AND OWNER.

SPECS, INC. ASSUMES NO RESPONSIBILITY OR LIABILITY FOR THE LOCATION AND/OR SIZE OF EXISTING UTILITIES. CONTRACTOR TO VERIFY LOCATION AND DEPTH OF ALL UTILITIES PRIOR TO THE START OF ANY EARTHWORK OR CONSTRUCTION.

. SEE SHEET CO.1 FOR SYMBOLS & ABBREVIATIONS LEGEND.

MEASURES FOR DISCHARGES TO THE CHESAPEAKE BAY, IMPAIRED WATERS WITH AN ESTABLISHED TOTAL MAXIMUM DAILY LOAD (TMDL).

DESIGNER'S SIGNATURE:

MR. RAYMOND CHARLES RASE, P.E.

R.C.R. CHECKED: DATE



PREPARED FOR: **GARRETT COLLEGE** 687 MOSSER ROAD McHENRY, MARYLAND 21541 (301) 387-3095

SPOIL SITE GARRETT COLLEGE **EROSION AND SEDIMENT CONTROL PLAN**

C4.0 5593 DRAWING No. DECEMBER 2 of 4

